OF

SITE IMPROVEMENT

ALDI DEN - STORE #178 1760 BRIARCREST DRIVE

**FOR** 

ALDI, Inc


CITY OF BRYAN

# INDEX OF DRAWINGS

SHEET No.


TITLE

COVER SHEET & INDEX PARKING LAYOUT DEMO & RECURBING

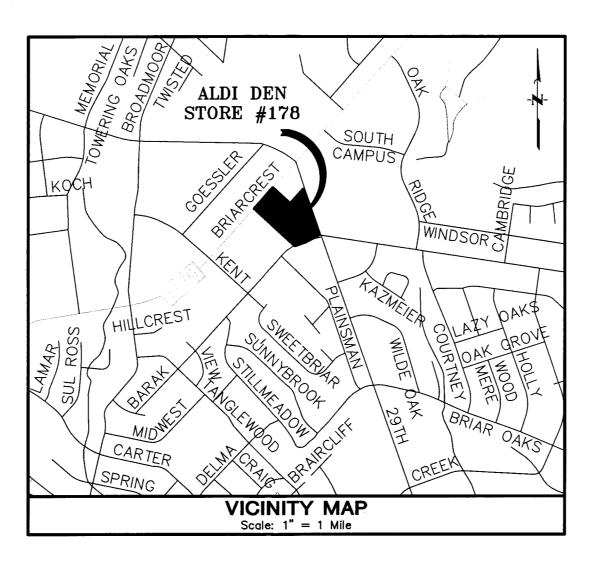

DECEMBER 2015




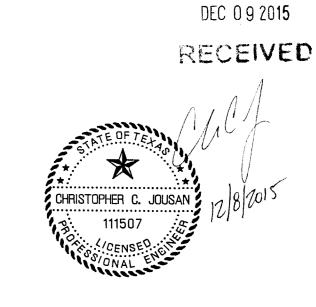



Development Services

SHEET No.

C:\Users\JMC2\appdata\local\temp\AcPublish\_7896\Aldi Bryan Site Plan.dwg Dec 08,2015 — 3:17pm JMC2

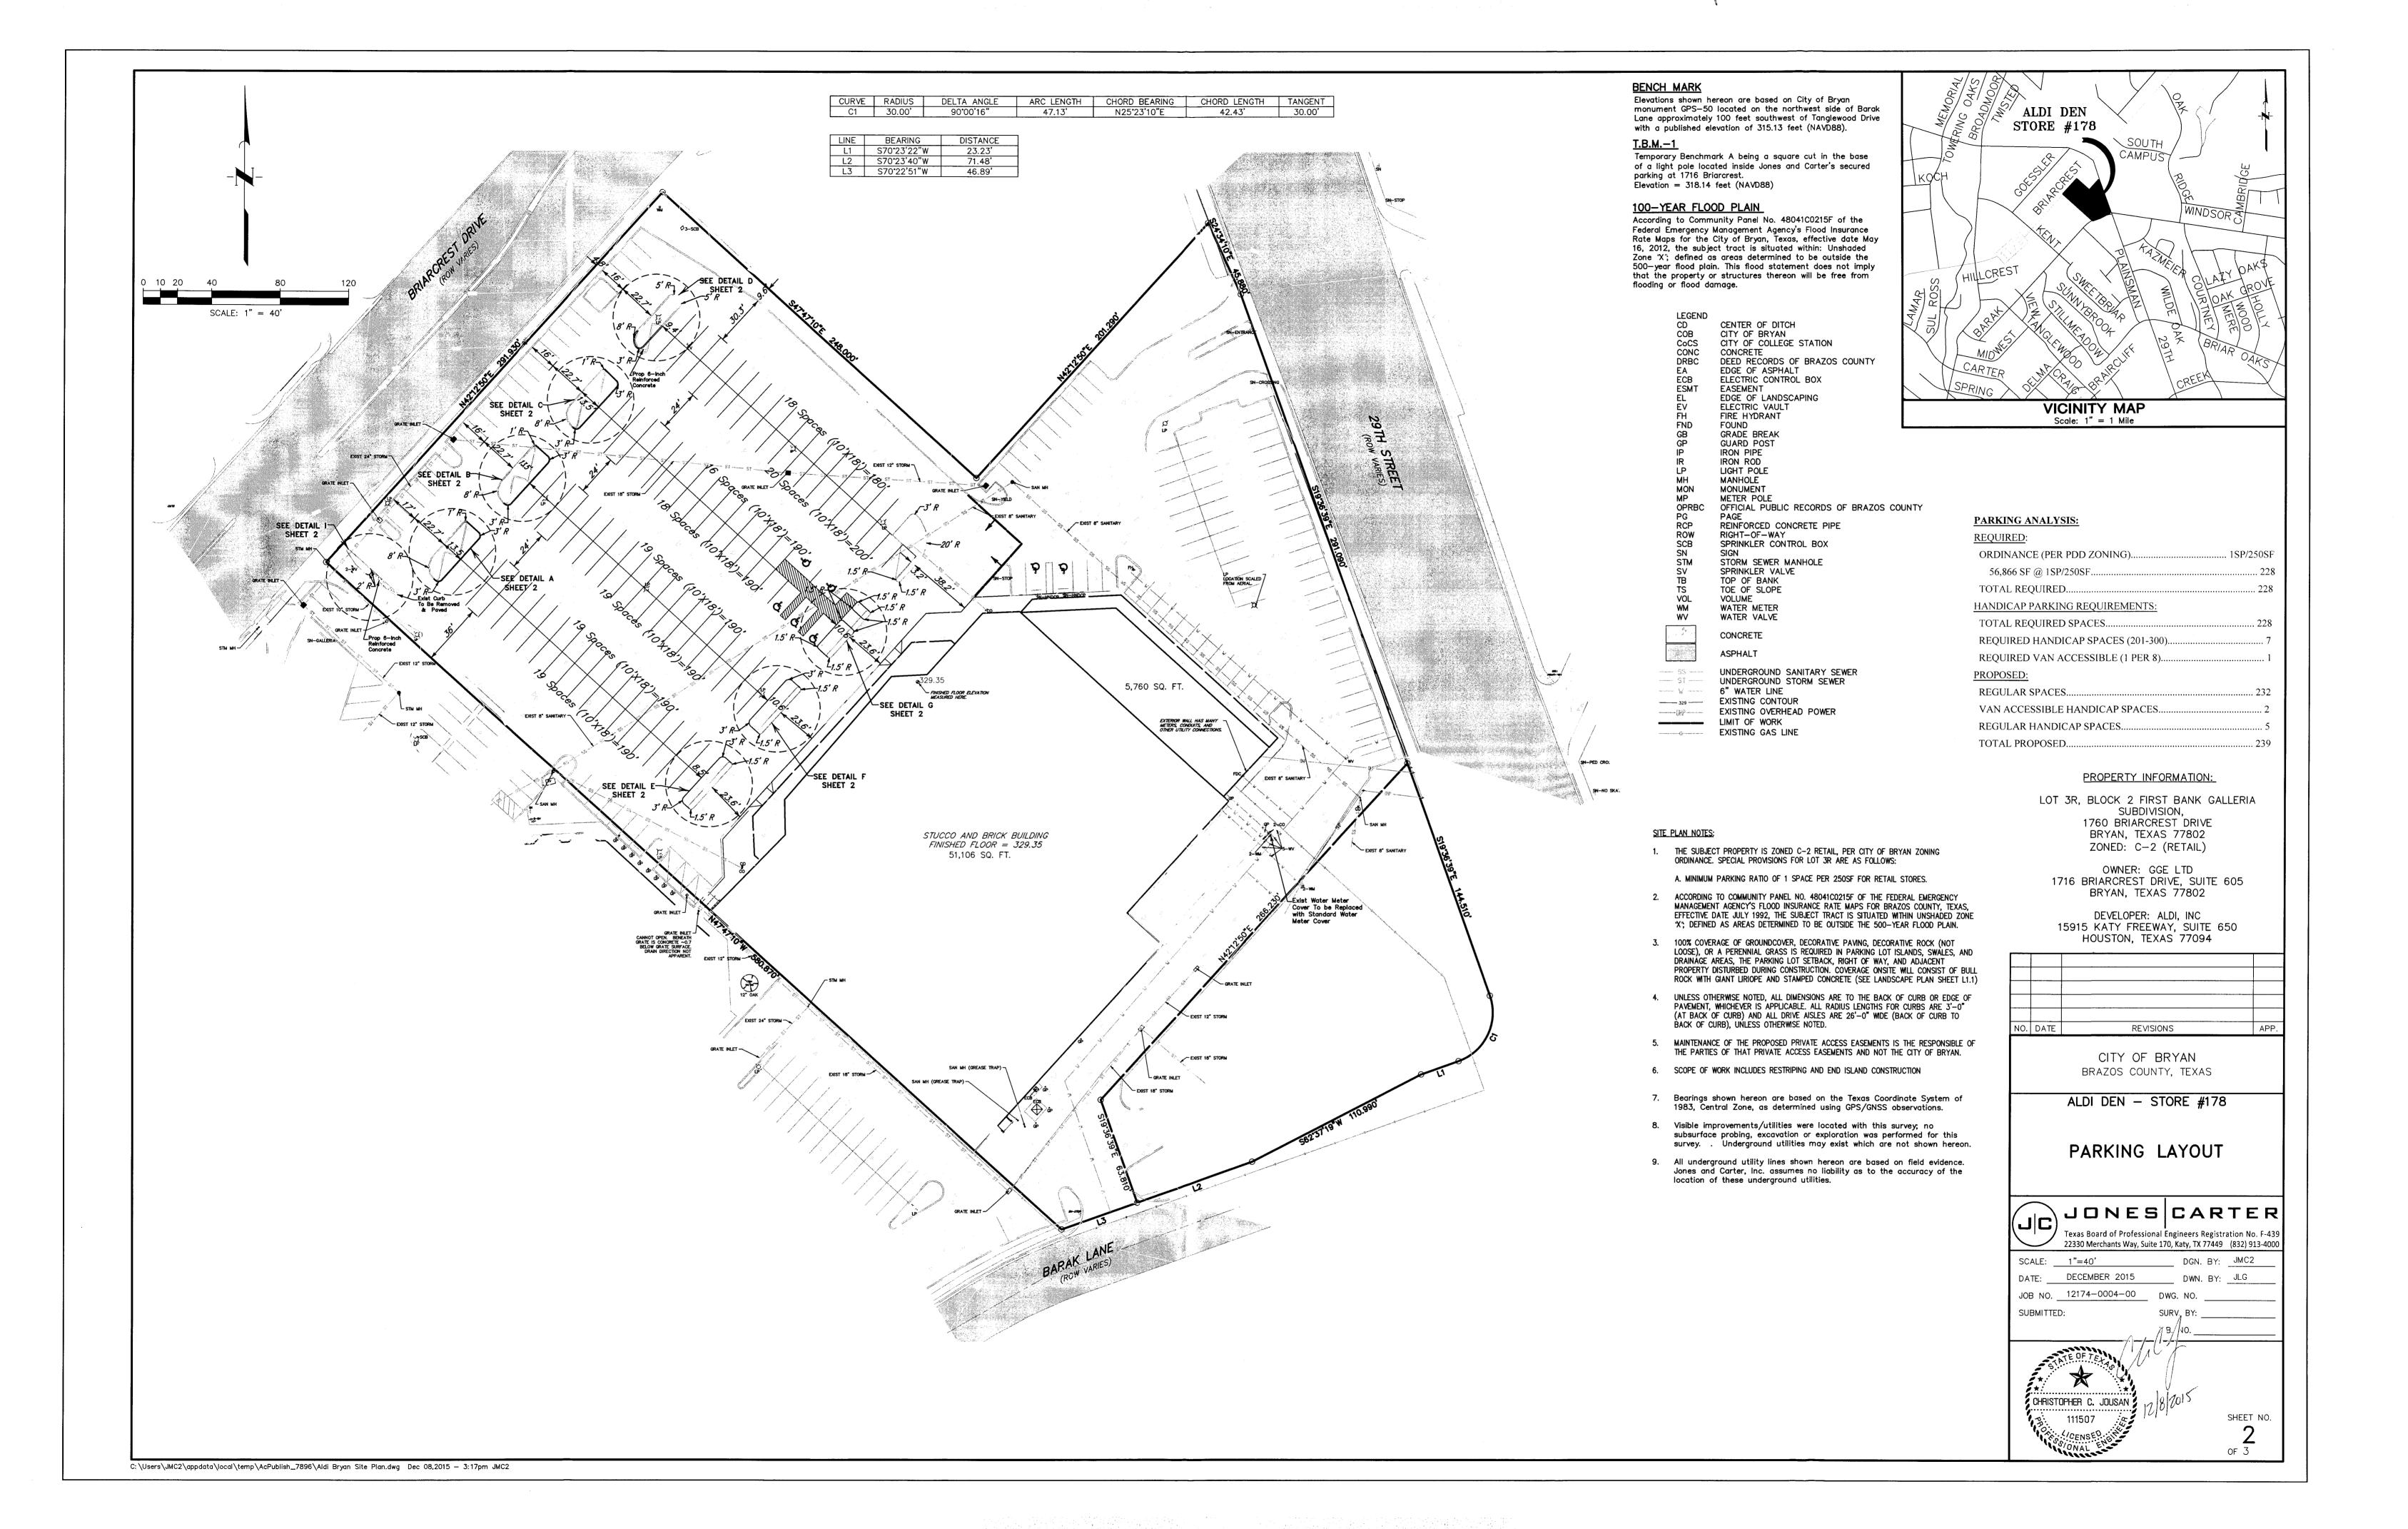

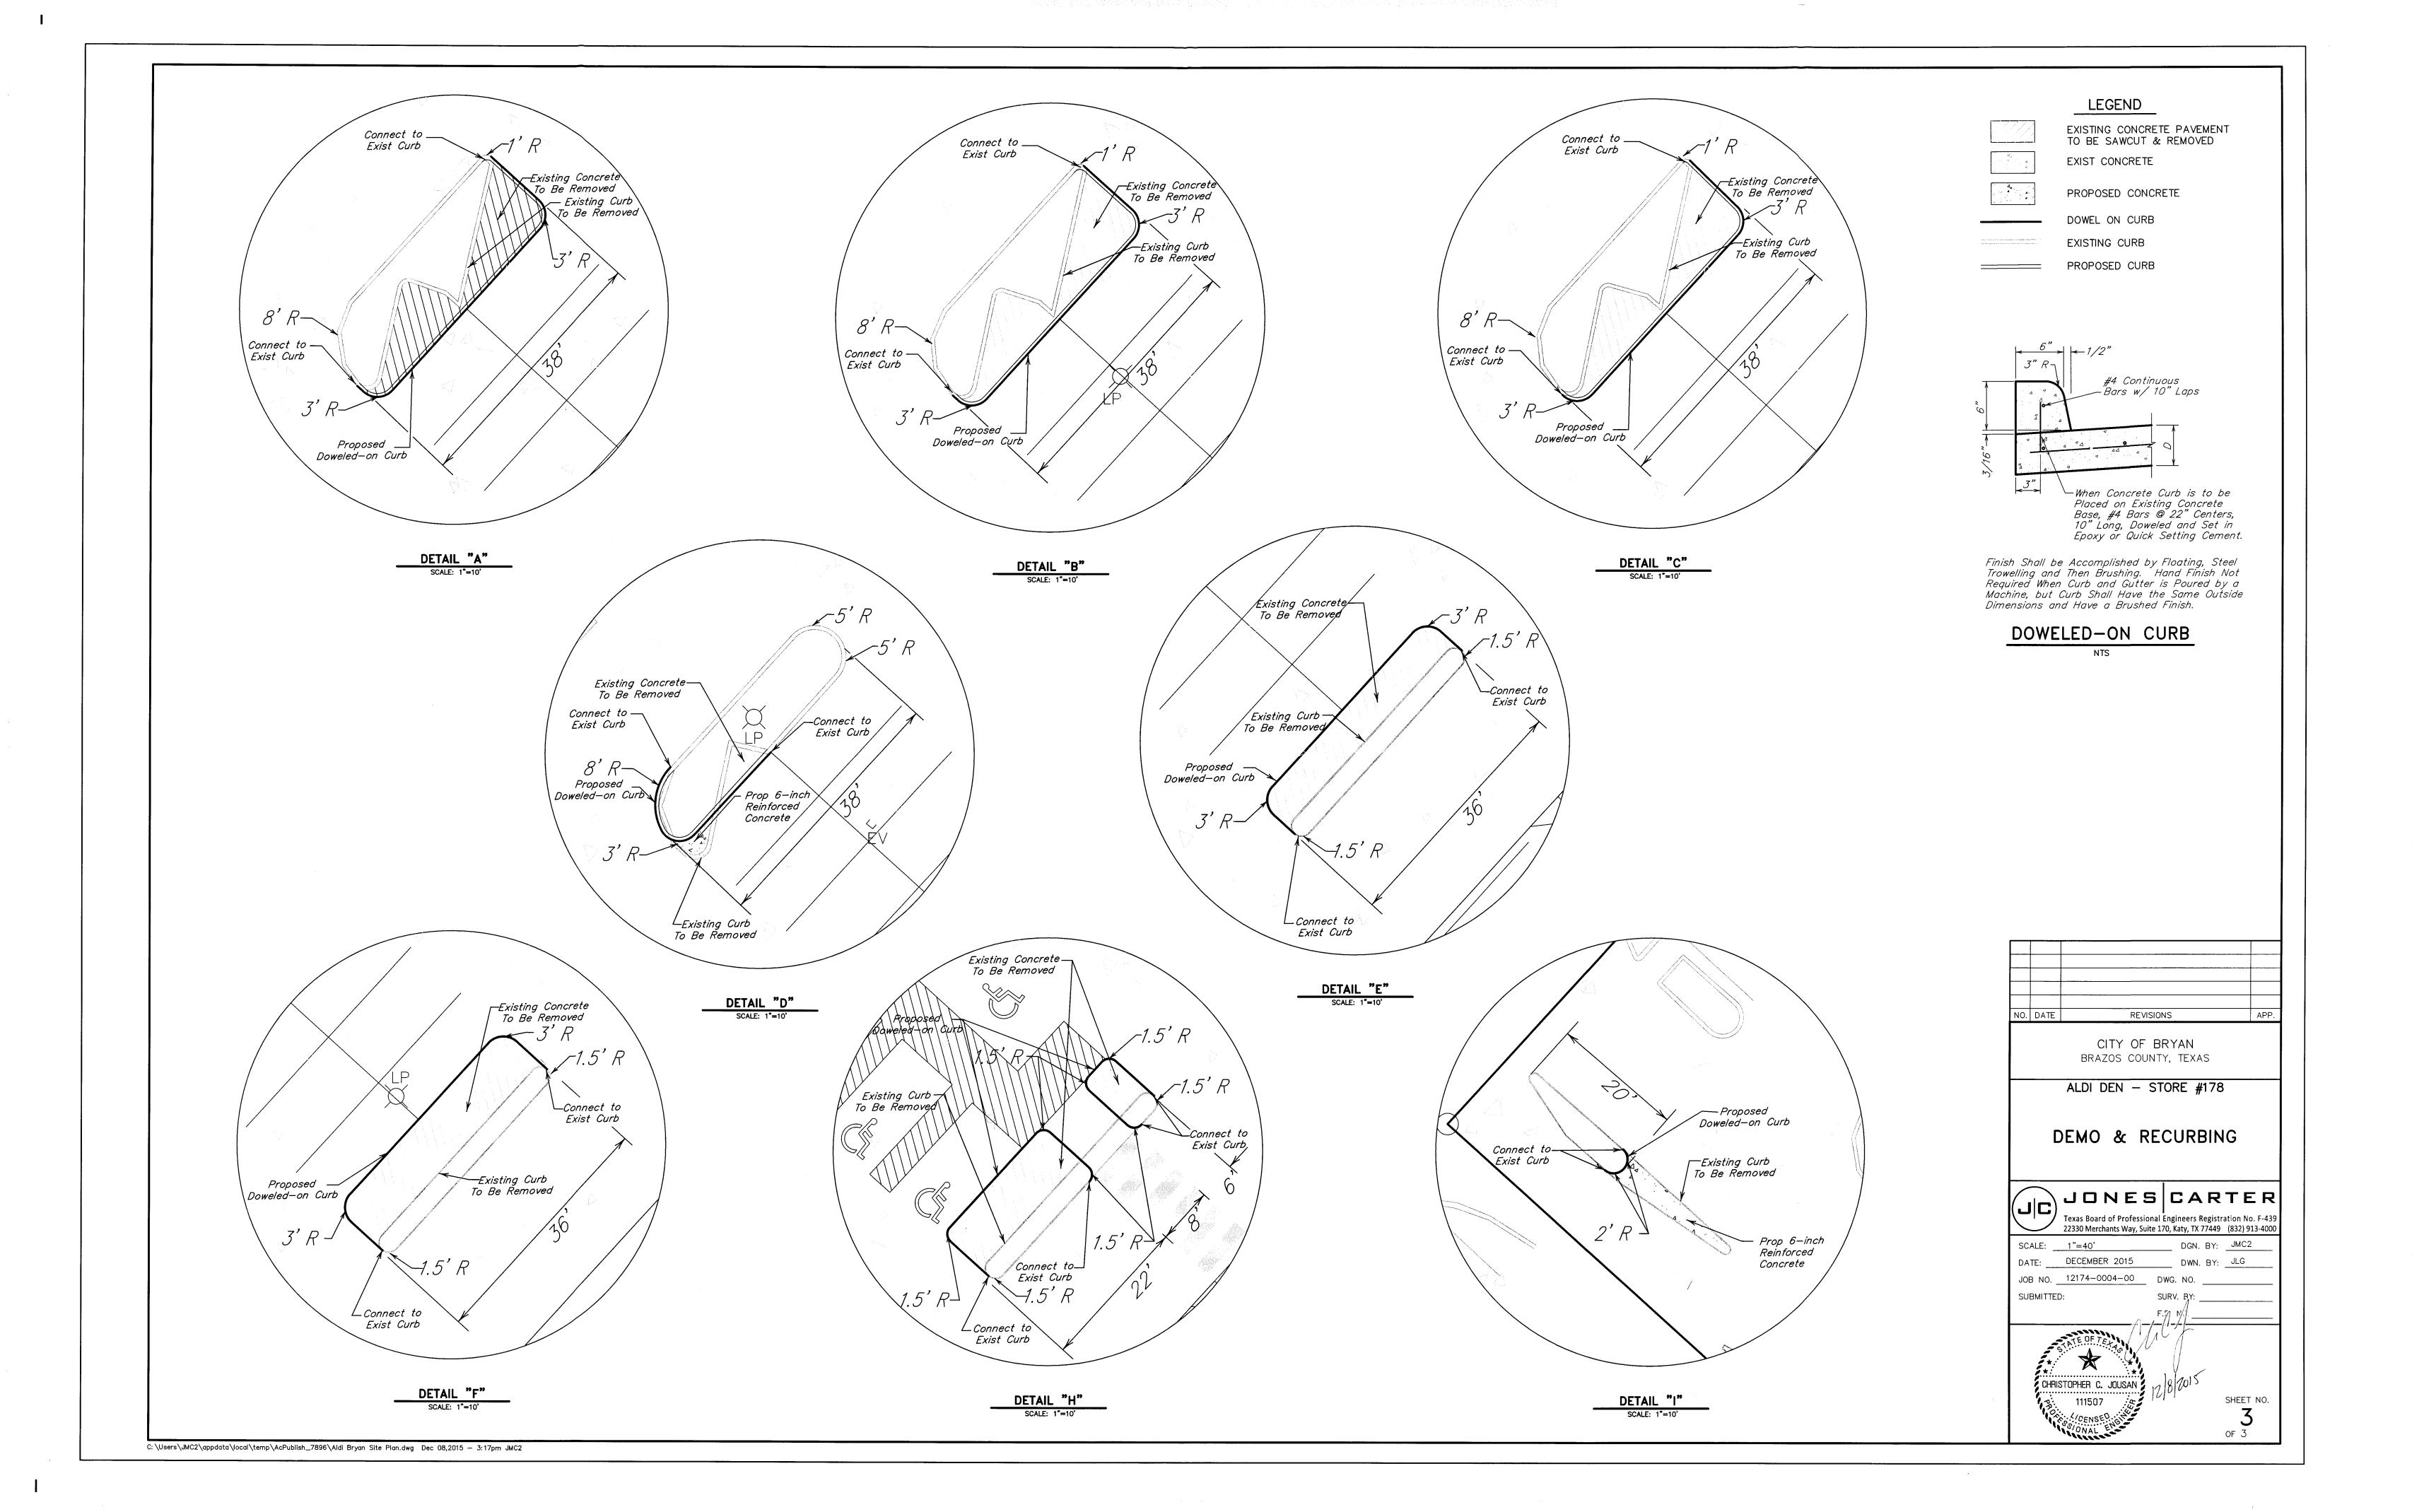

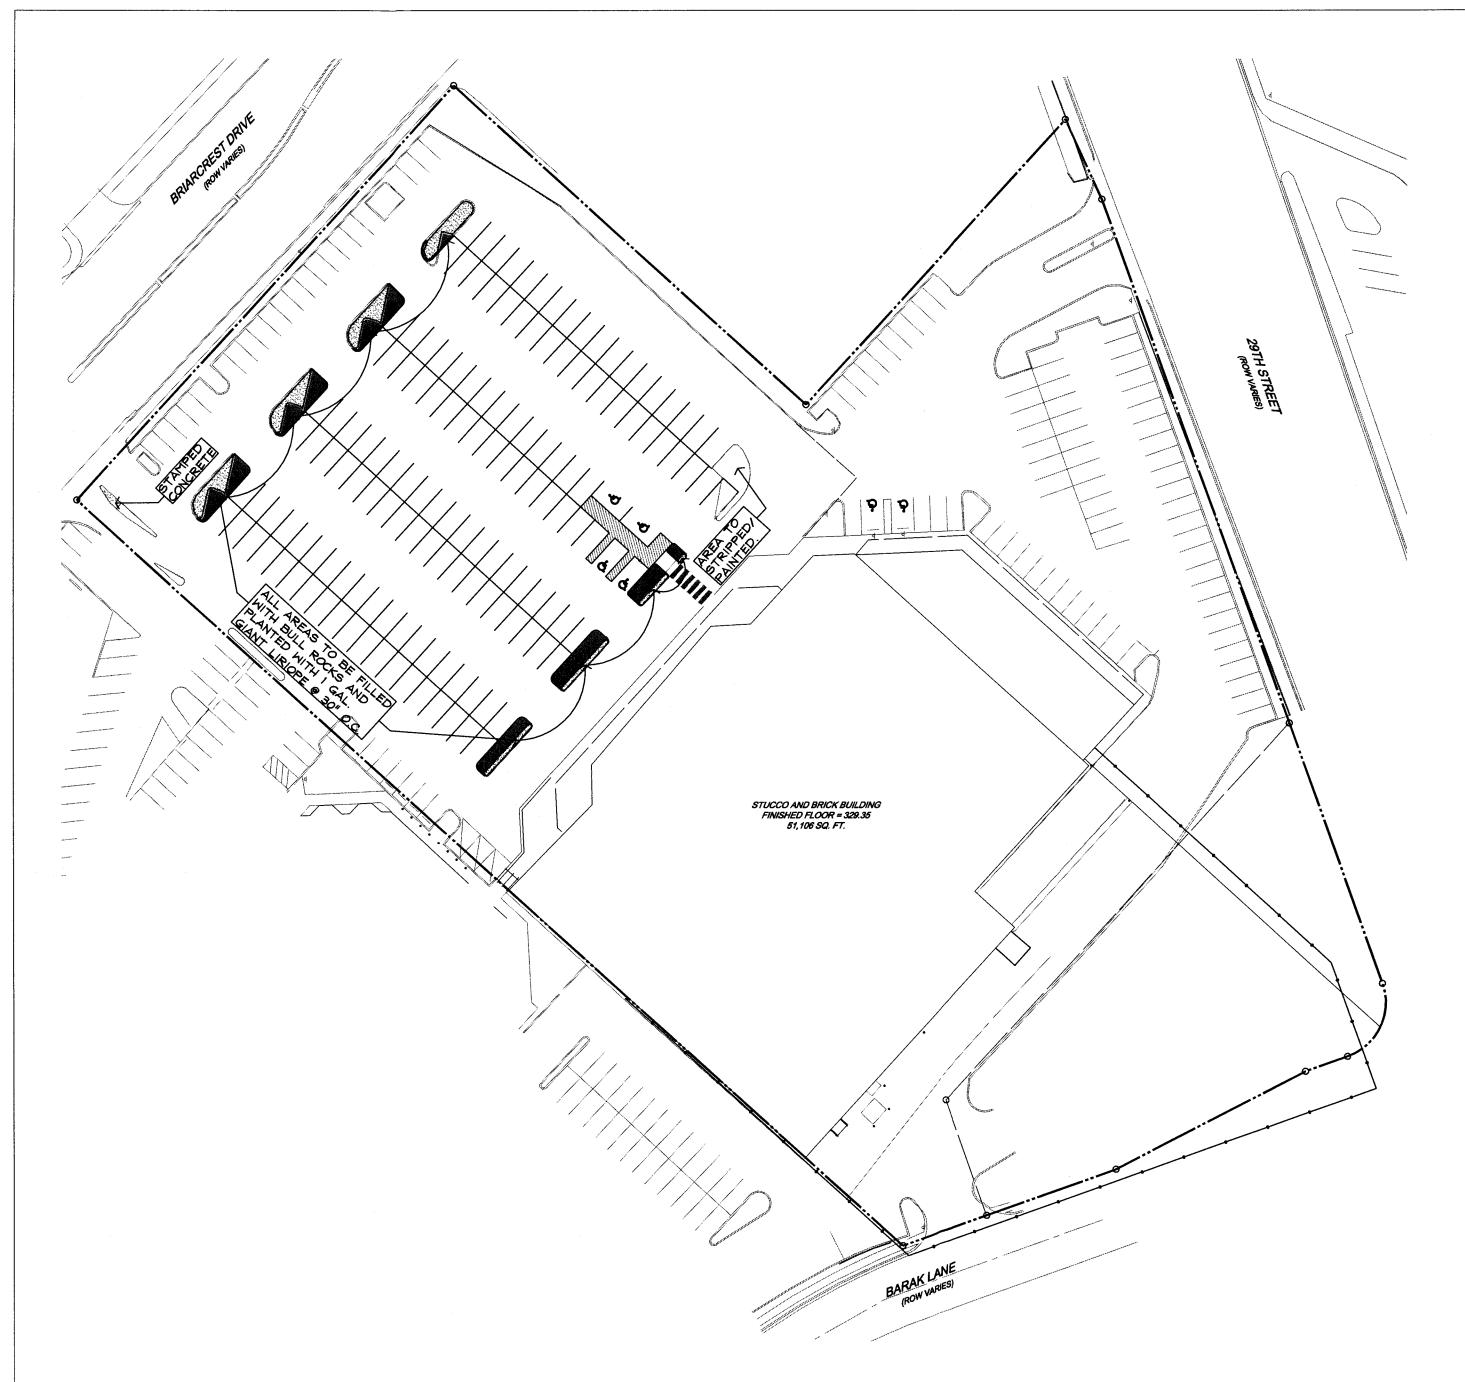

Owner's Responsibility For Maintenance Client acknowledges and agrees that proper Project maintenance is required after the Project is complete. A lack of or improper maintenance in areas such as, but not limited to, operation and maintenance of automatic irrigation system, all site drainage and all planting materials maintenance may result in damage to property or persons. Client further acknowledges that he is solely responsible for the results of any lack of or improper maintenance.


Landscape Contractor's Responsibilities: All drainage (surface and subsurface) of all landscape areas within the project limits shall be the responsibility of the installing landscape contractor and landscape maintenance company. All grading of areas along all building areas must absolutely have positive slope away from building. In no case shall any plant bed be constructed along edge of building that will impede water flow away from building. If planting beds are located at edges of building, landscape contractor shall make sure that these areas drain properly (surface and subsurface-wise). Contractor shall install moisture barrier along building as necessary to keep water from penetrating underneath building


"REFER TO FINISHED GRADES SHOWN ON PROJECT CIVIL GRADING PLAN. IT WILL REPRESENT FINAL ELEVATIONS, CARE SHOULD BE TAKEN BY THE LANDSCAPE CONTRACTOR NOT TO INCREASE THESE FINISHED GRADES WITH LANDSCAPING OR OTHER ALTERATIONS. THE THICKNESS OF SOD, GRASS AND LANDSCAPING MATERIALS SHOULD BE DEDUCTED FROM THE FINISHED GRADE ELEVATIONS IN THESE CIVIL GRADING PLANS IN ORDER TO DETERMINE THE GROUND ELEVATIONS **DURING CONSTRUCTION."** 

Note:	_
All other areas to remain undisturbed.	

#### Landscape Legend:

Symbolic Name	Quantities (Verify)	Botanical Name	Common Name	Size and Plant Requirements
Bull Rock	Verify	A		Proposed areas to receive a minimum 3" inch layer of washed bull rock (1" to 1-1/2" diameter) Install approved filter / weed control fabric membrane underneath areas to receive bull rock.
Pavers	Verify	В		Proposed areas to receive approved stamped concrete or special paverstones. Owner will determine finish for subject area on site.  Alternate No.1: Bomanite Stamped concrete with color and patterns as selected by Owner. Alternate No. 2: Install approved pavestone materials over existing paved parking island where noted.

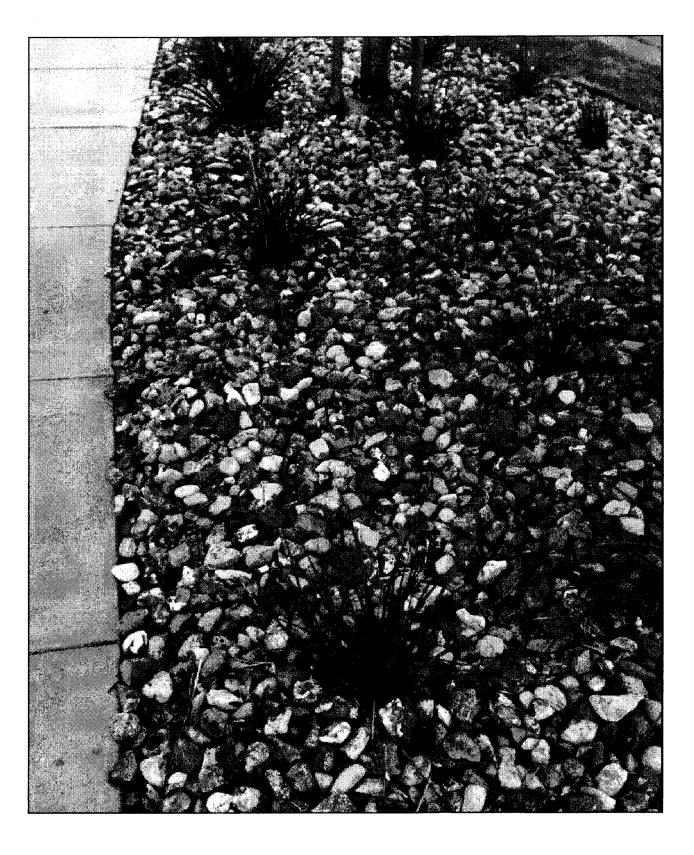

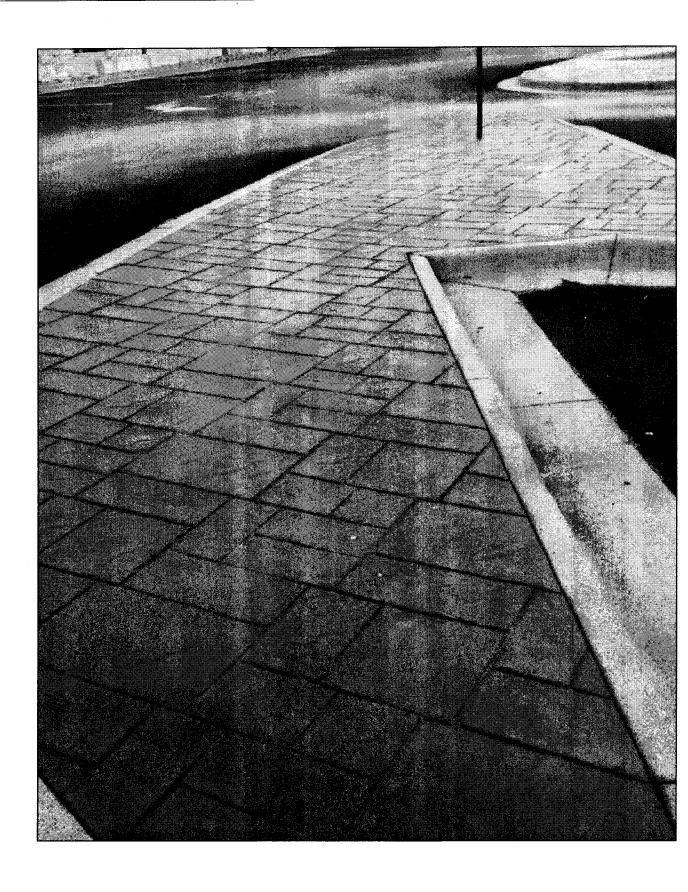



## **BULL ROCK WITH GIANT LIRIOPE**

SCALE: NTS

# STAMPED CONCRETE

SCALE: NTS

### **Landscape Requirements:**

- Perform all work in accordance with all applicable laws, codes, and regulations required by authorities having jurisdiction over such work and provide all inspections and permits required by Federal, State, and local authorities in supply, transportation, and installation of materials.
- 2. The contractor shall be responsible for the verification of all underground utility lines (telephone, gas, water, electrical, cable, TV, etc.) and all overhead utility easements prior to start
- 3. All plant materials shall possess the following minimum qualities: Plants shall be nursery grown in accordance with good horticultural practices under climatic conditions similar to those of the project for at least twelve months.
- All plants shall be heavy, symmetrical, tightly knit, so trained or favored for development and appearance as to be superior in form, number of branches, compactness, and
- Plants shall be sound, healthy and vigorous, well branched, and densely foliated when in leaf. They shall be free of disease, insects, pests, eggs, or larvae. All plants shall be true of species and variety and shall conform to measurements (caliper size, trunk heights, spread) as specified on the drawings.
- Container grown stock when specified shall have grown in the container in which delivered for at least six months, but not over two years. Samples must prove no rootbound Caliper measurements shall be taken at a point on the trunk six inches (6") above natural ground line for trees up to four inches (4") in caliper.
- All trees shall be staked by a minimum of two metal "T" stakes for single trunk trees and three stakes for all multi-trunk trees.
- 4. Planting mix shall be thoroughly mixed in the following proportions:
- a. Prepared soil as backfill for shade and ornamental trees shall be: 5 part clay loam topsoil + 2 part compost + 1 part sharp sand + 4 Lbs. Commercial fertilizer per CY Or 10 Lbs.
- Prepared soil as backfill for shrubs and groundcovers and seasonal colors shall be: 1 part enriched mulch + 1 part compost bark mulch + 1 part enriched topsoil + 1 part No. 1 Bank Sand + 3 Lbs. Time- released fertilizer, 14-14-14 per CY or 8 Lbs. Organic fertilizer.
- 5. Excavation work and Surface drainage works shall conform to the following requirements:
  - a. Test drainage of plant beds and plant pits by filling with water twice in succession. Conditions permitting the retention of water for more than 24 hours shall be brought to the attention of the Owner.
  - b. Work shall include the final responsibility for proper surface drainage of planted areas. Any obstructions on the site, or prior work done by another part, which precludes establishing proper drainage shall be brought to the attention of the Owner in writing.
  - Excavate each tree hole 18" deep plus the depth of the tree container size (15 gal. Or 30 gal. Or 65 gal. Or 100 gal.).
  - Excavate entire shrub bed to a depth of 8" plus the depth of the shrub container size (5 gal.) unless noted as being pit planted on landscape legend. e. Excavate entire groundcover bed to a depth of 6" plus the depth of the groundcover container size (4" pot or 1 gal.).
- 6. Additional work requirements on landscape areas:
- a. Prior to installation of any planting works (trees, shrubs,groundcover and grass works); apply "Round Up" in all planting areas to eradicate all weed growths on site. b. Install weed control barriers in all trees, shrub and groundcover planting areas. Weed barrier fabric shall be black polypropylene sheet 27 mils thick, 4 oz/s.y. grab tensile
- strength per ASTM D-4632; 90 lbs. (machine direction) 50 lbs. (cross machine direction). Provide DeWitt "Weed Barrier" or aprpoved substitute.
- c. Edge all planting bed areas with Ryerson steel edging to clearly define the edge of the planting bed the start of the grass areas. Edging shall be Ryerson estate Curb, 1/8"x4" with new stakes free of rust.
- d. Spread a minimum two inch layer of pine bark mulch overall shrub and groundcover bed areas.
- 7. Landscape maintenance work by the Landscape Contractor after final acceptance shall include the following:
- a. The maintenance period shall commence upon inspection and approval at Final Acceptance and shall be for a period of Thirty Days (30).
- b. The landscape contractor shall coordinate the watering program for all the landscape work with the Owner.
- c. Maintenance of new plantings shall consist of watering, cultivating, weeding, mulching, restaking, tightening and repair of guys; resetting plants for proper grades or upright position, and furnishing and application of pesticides/herbicides; sprays, and invigorants as are necessary to keep plantings free of insects and disease and in a thriving
- 8. Warranty Periods, Plant Guarantees, and Replacements:
- a. Planting supplied shall be warranted to remain alive and healthy for a period of twelve months (12) after the date of Final Acceptance by Owner. Plants in an impaired, dead, or dying condition after initial acceptance or within 12 months shall be removed and replaced immediately to the satisfaction of the Owner.

1. | 11.04.15 | ISSUED FOR PERMIT NO. DATE REVISIONS APP. CITY OF BRYAN

BRAZOS COUNTY, TEXAS

LANDSCAPE PLAN

BRAZOS COUNTY, TEXAS

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SCALE: _	AS NOTED	DGN. BY: <u>EW</u>
DATE:	DECEMBER 2015	DWN. BY: <u>EW/S</u> F
JOB NO.	12174-0004-00	DWG. NO.
SUBMITTE	<b>)</b> :	SURV. BY:



Vong & Associates, Inc.

Bellaire, Texas 77402-2028

F.B. NO. \_\_

